




3 PLAN DETAIL
SCALE: 1" = 1'-0"

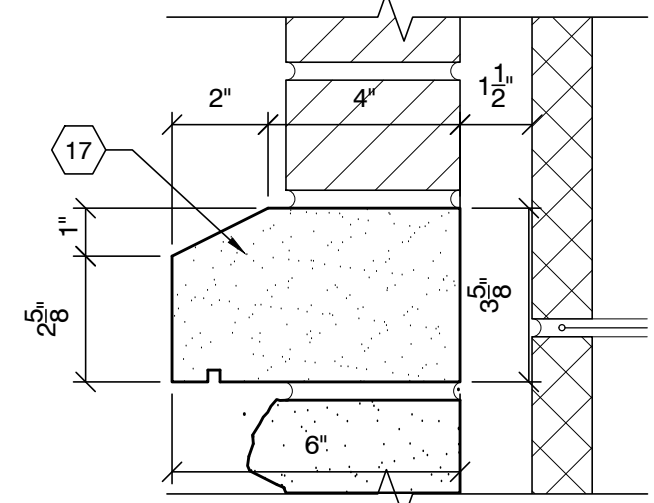




5 WATERTABLE DETAIL
SCALE: 1" = 1'-0"

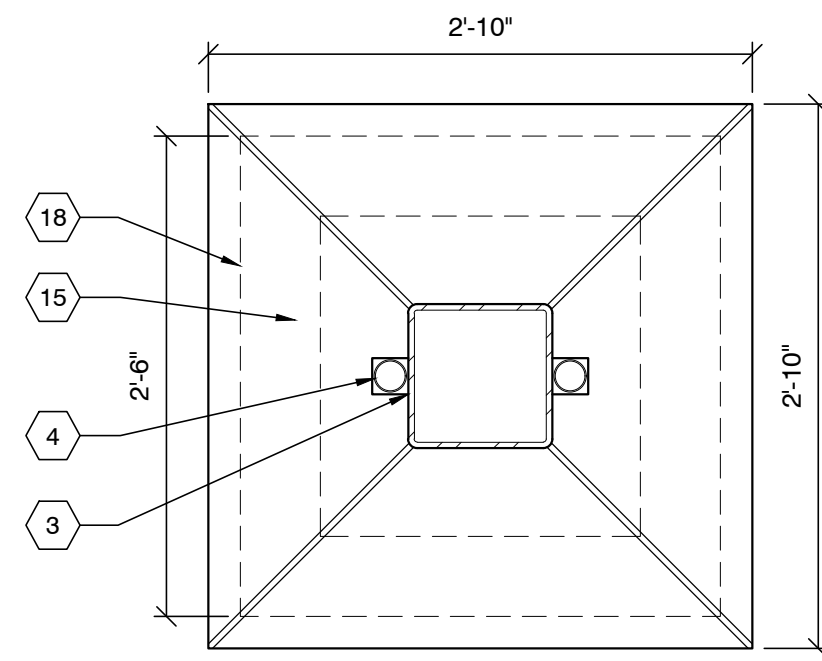


7 COLUMN CAP DETAIL
SCALE: 1" = 1'-0"

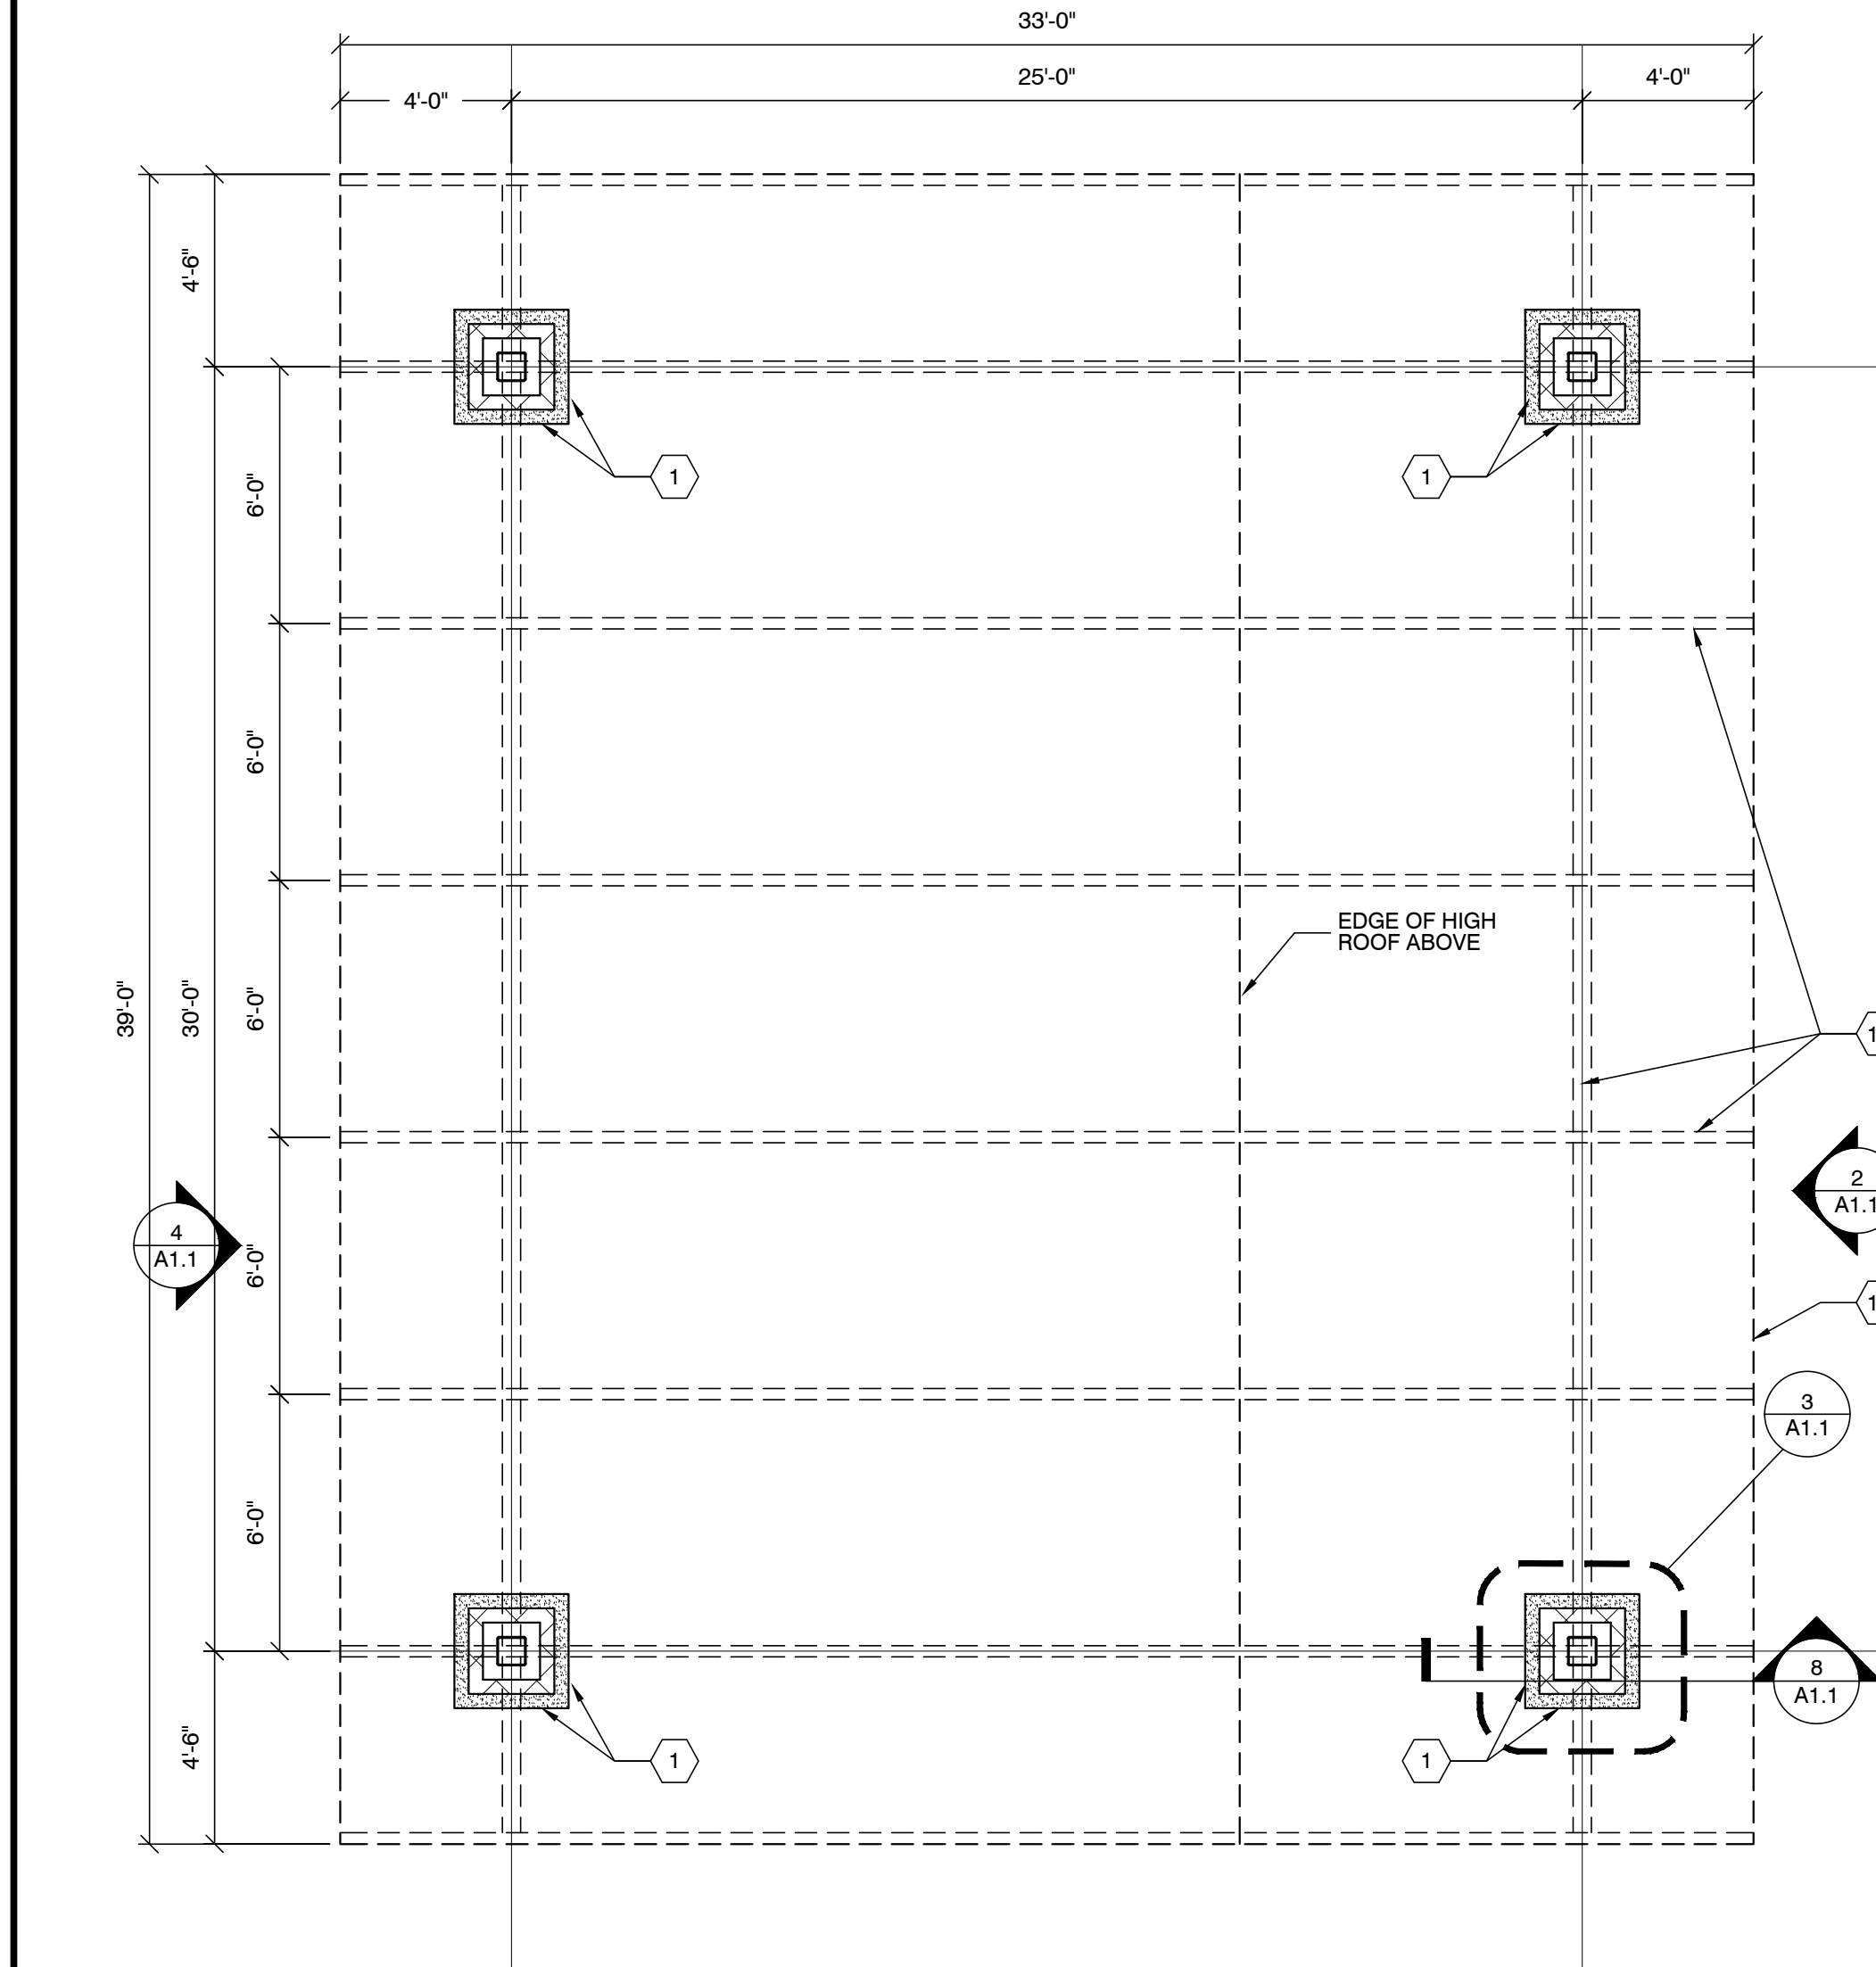


1 FLOOR PLAN
SCALE: 1/4" = 1'-0"

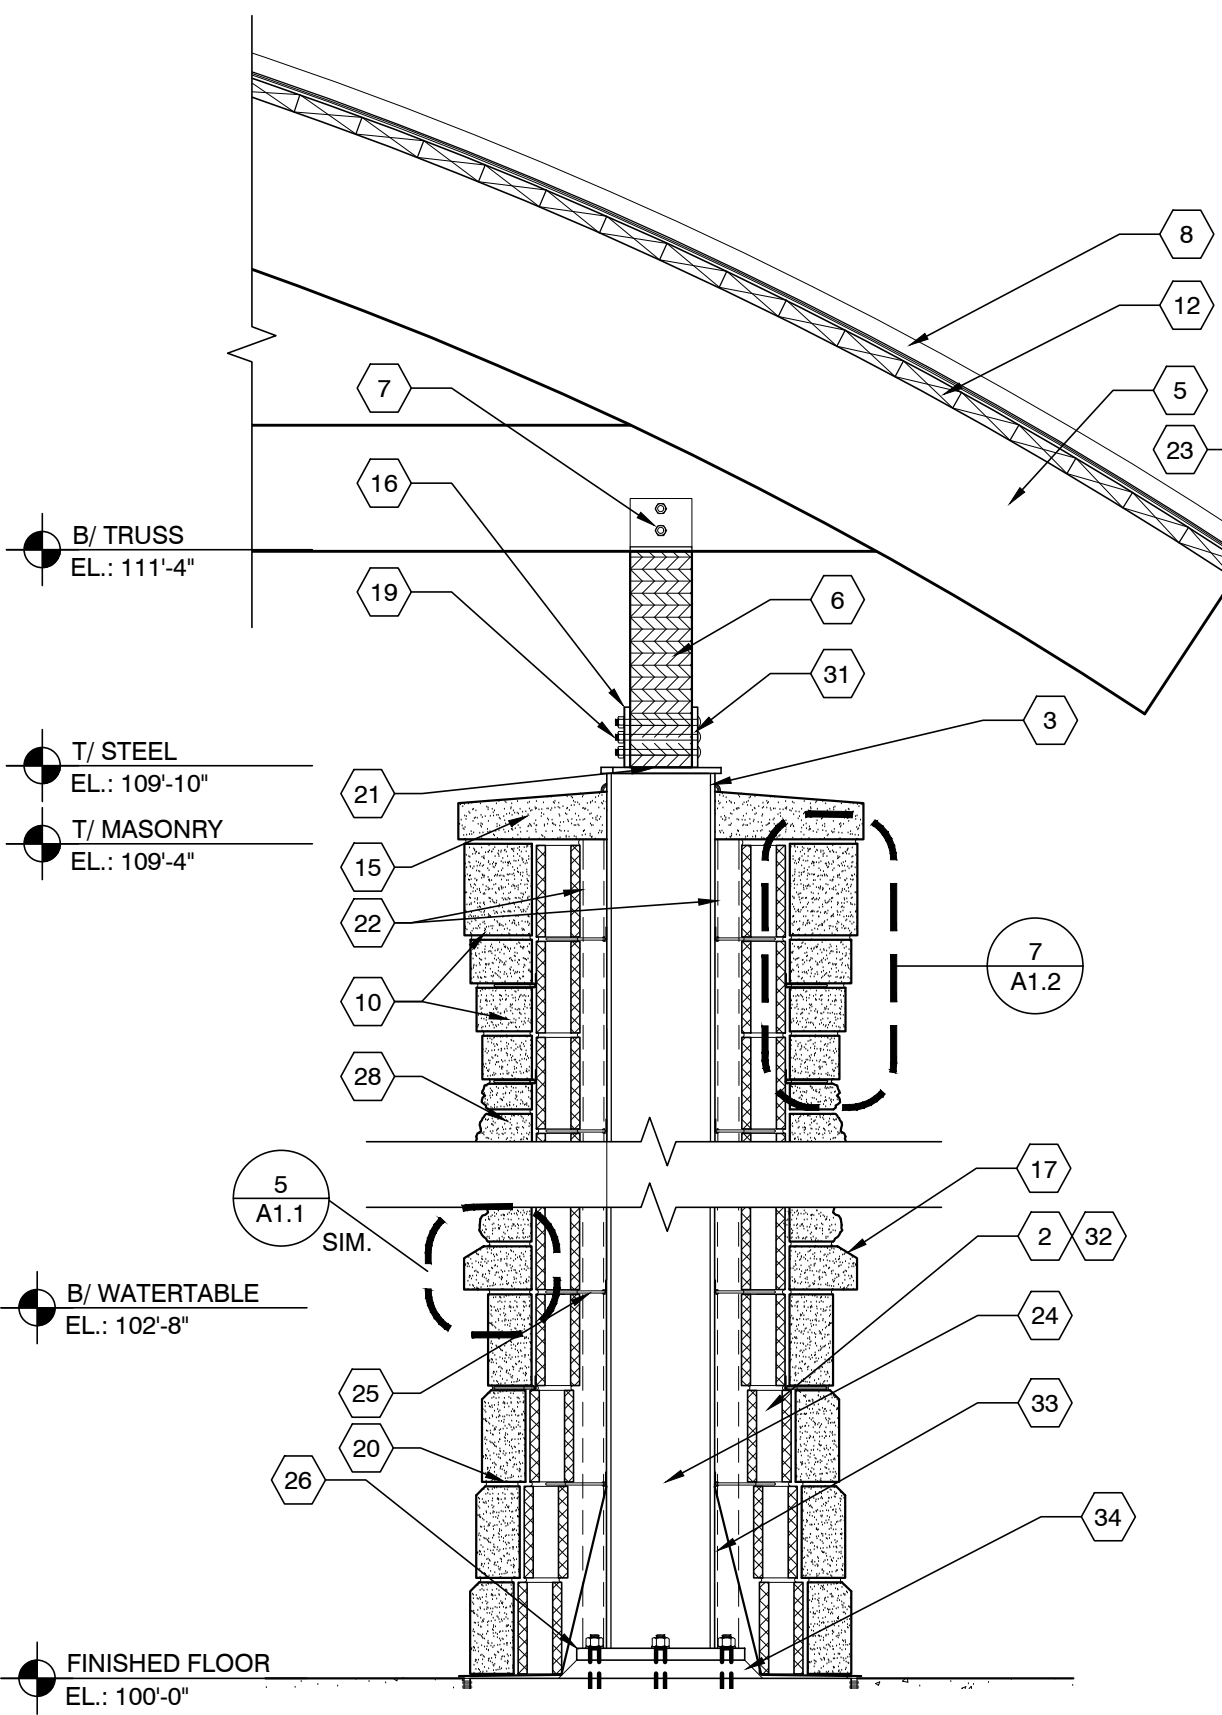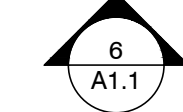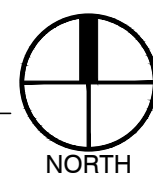


8 WALL SECTION
SCALE: 3/4" = 1'-0"

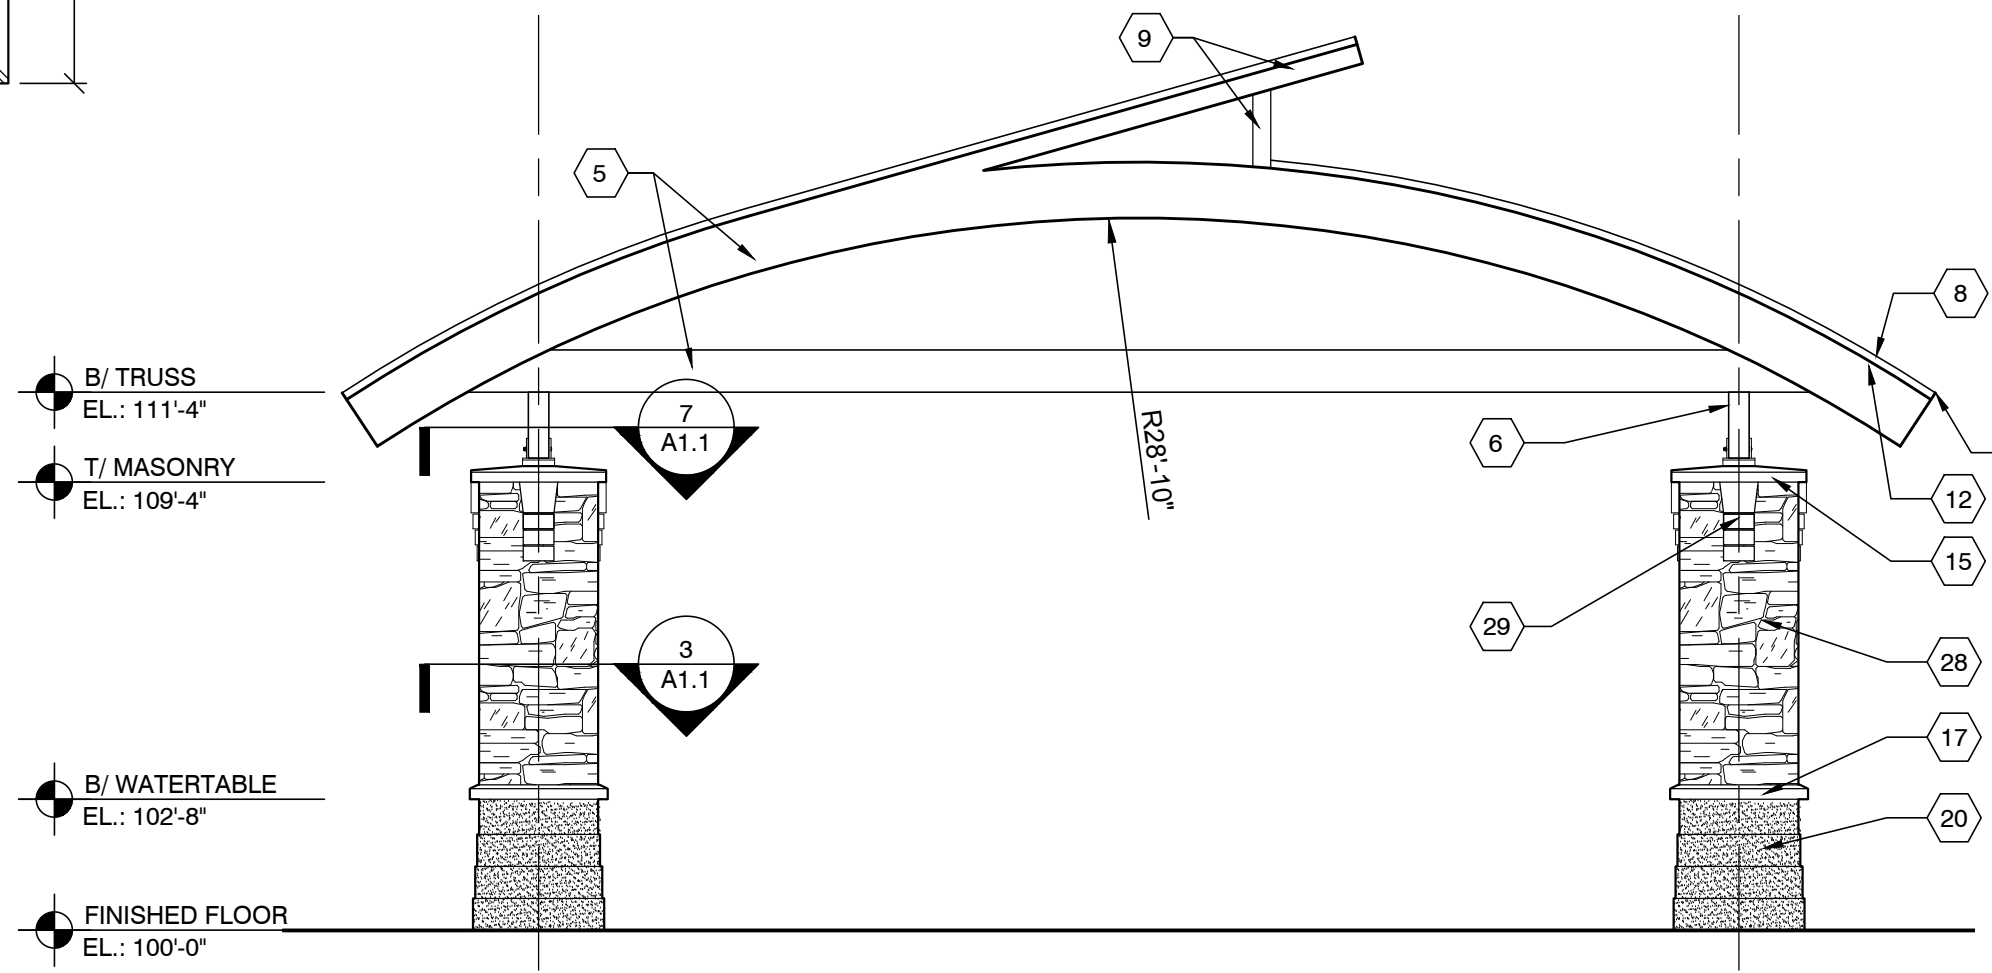

6 SOUTH ELEVATION
SCALE: 1/4" = 1'-0"

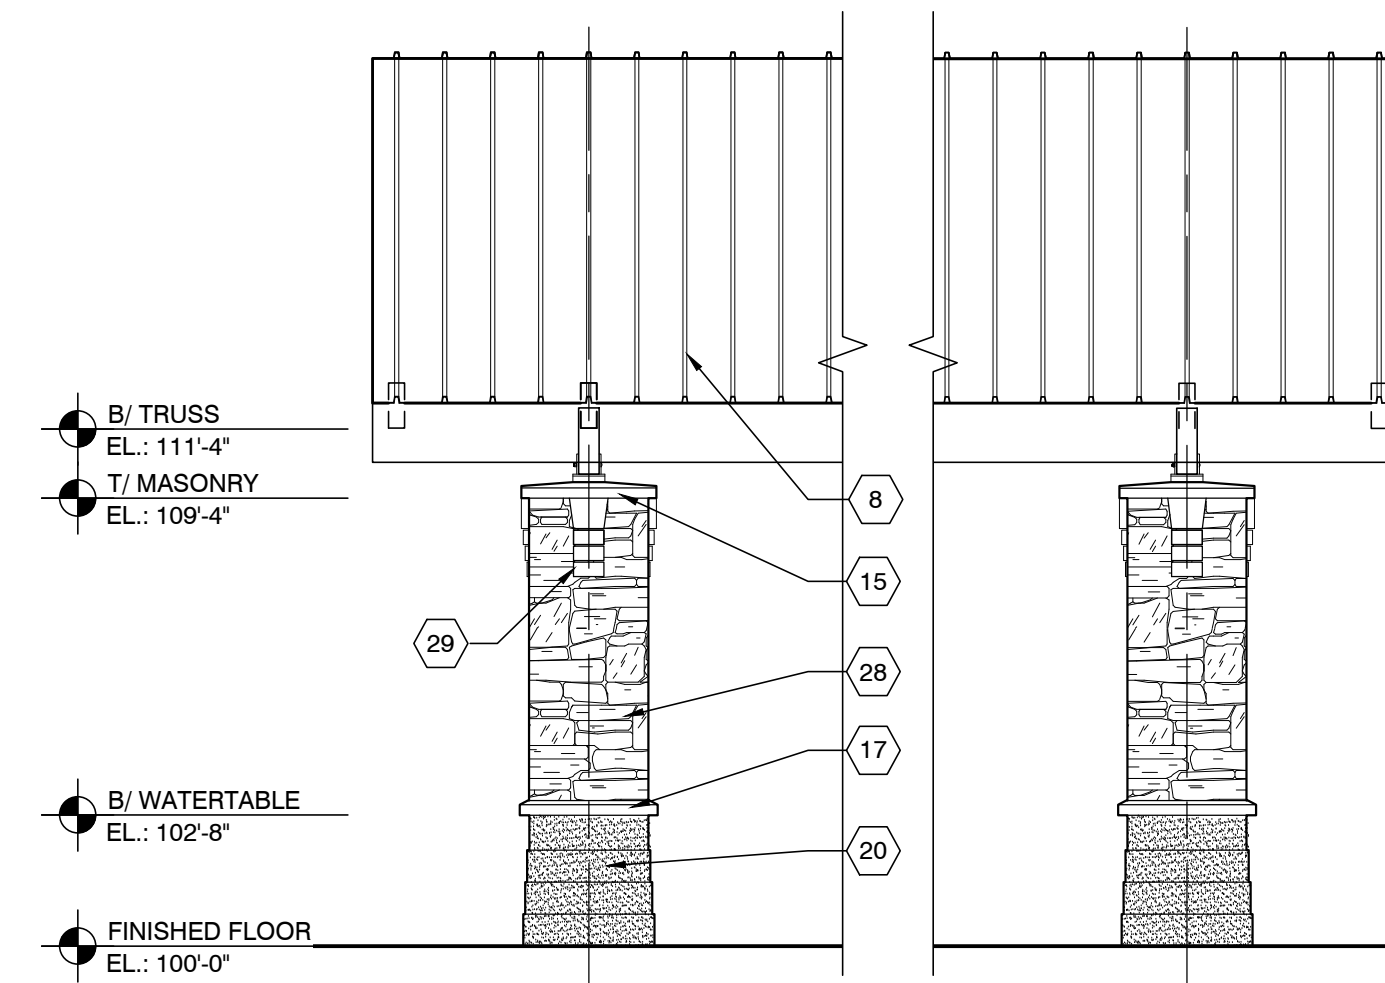

4 WEST ELEVATION
SCALE: 1/4" = 1'-0"

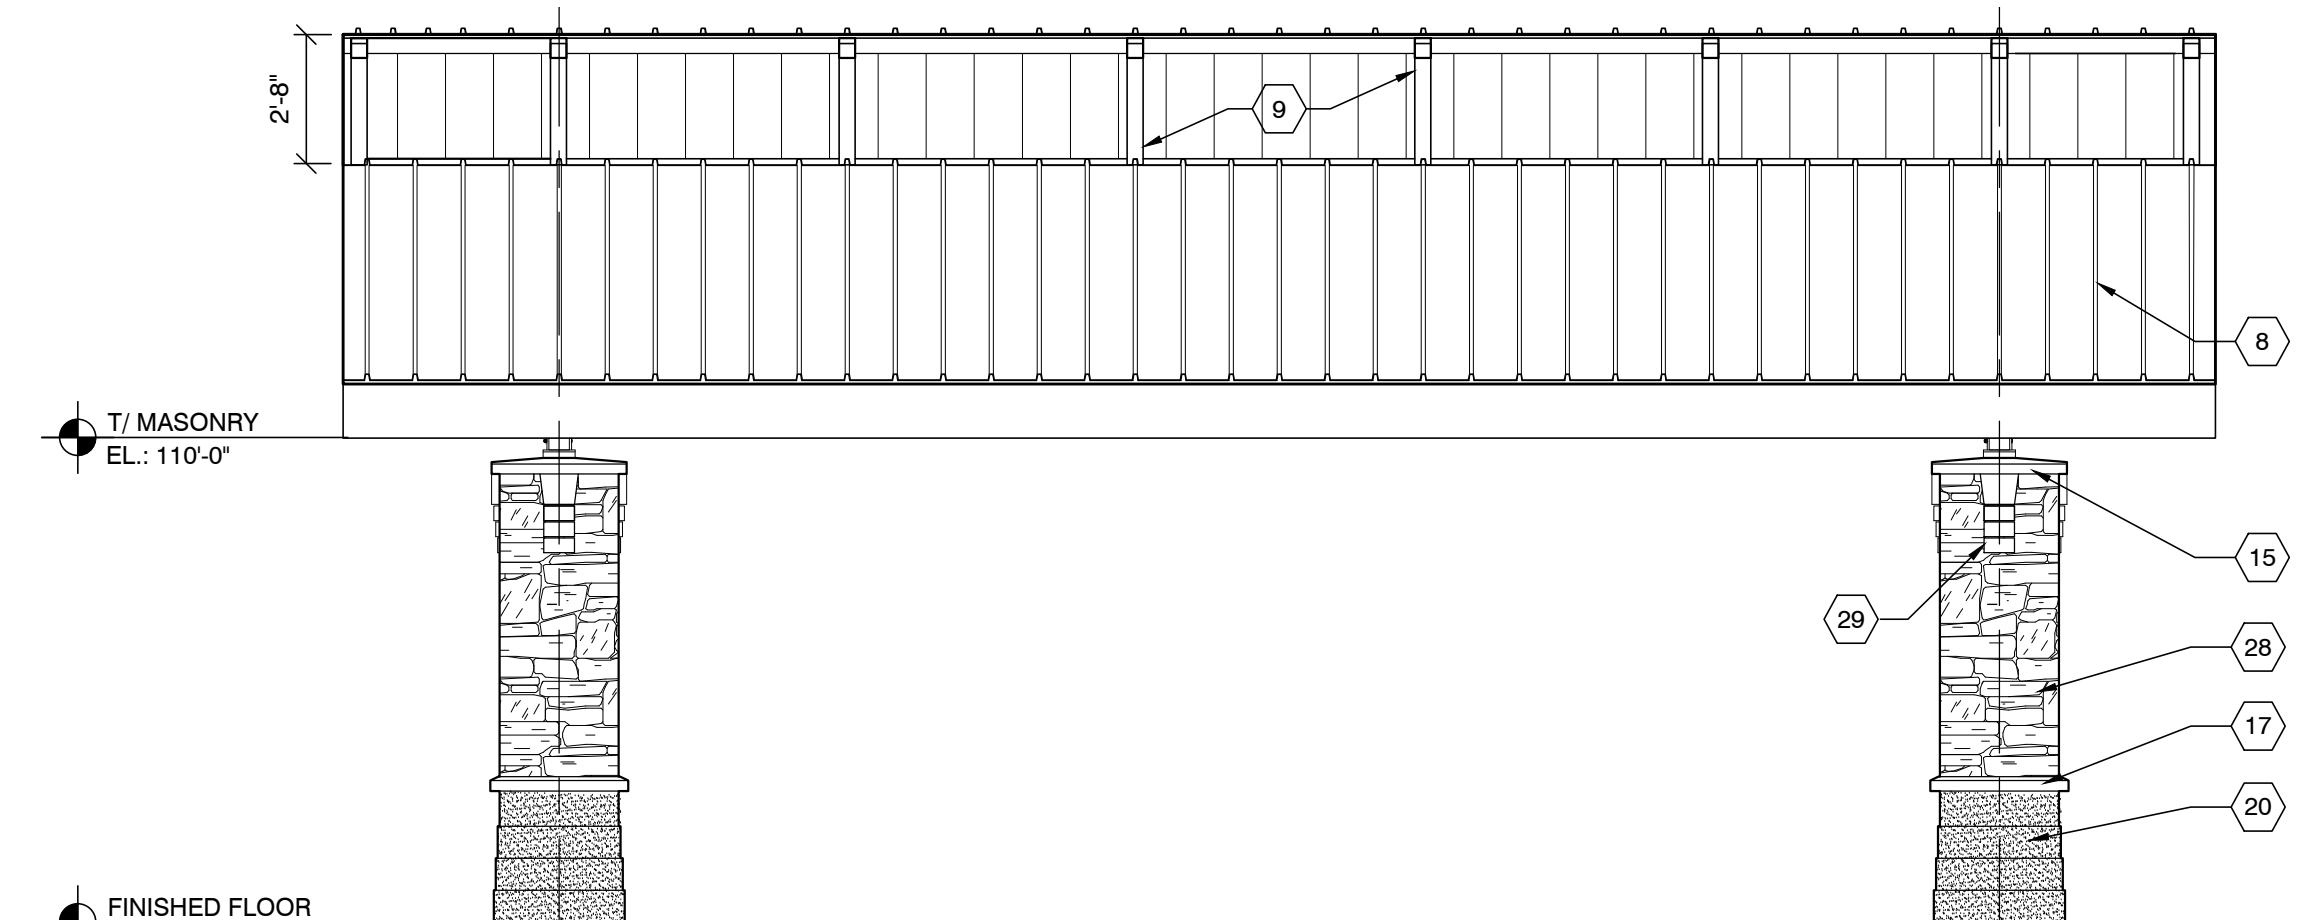


2 EAST ELEVATION
SCALE: 1/4" = 1'-0"

GENERAL NOTES

1. FINISH FLOOR ELEVATION OF 100'-0" IS EQUAL TO USGS ELEVATIONS OF 828'-4" UNLESS NOTED OTHERWISE.
2. PROVIDE SEALANT AT JOINTS BETWEEN ALL DISSIMILAR MATERIALS.
3. FINISH SLAB ELEVATION MAY VARY DUE TO SLOPE. REFER TO CIVIL DRAWINGS FOR EXACT ELEVATIONS.
4. ALL EXPOSED EXTERIOR STEEL TO BE GALVANIZED AND SHOP PRIMED. PAINT O.F.O.I.

KEYNOTES

1. 1/2" EXPANSION MATERIAL AND SEALANT JOINT AT PERIMETER OF CONCRETE SLAB AND AROUND ALL COLUMNS.
2. 4" CMU.
3. SEALANT AROUND COLUMNS AND CONDUIT PENETRATION.
4. NOTCH PRECAST CAP FOR 1 3/4" CONDUIT. CONTRACTOR TO VERIFY SIZE WITH OWNER PRIOR TO INSTALLATION.
5. GLUE LAMINATED BOWSTRING TRUSS - DESIGNED BY CONTRACTOR.
6. 6 3/4" X 22" GLUE LAMINATED BEAM.
7. SIMPSON TIE-DOWN CONNECTION - COORDINATE WITH TRUSS CHORD WIDTH - BY MANUFACTURER.
8. METAL STANDING SEAM ROOF.
9. GLUE LAMINATED CLERESTORY FRAMING - DESIGNED BY CONTRACTOR.
10. PRECAST TRIM KEYSTONE - COLOR GLASIER MIST - CUSTOM CAST STONE.
11. PROVIDE MASONRY TIES @ 2'-0" ELEVATION INCREMENTS.
12. 2x6 T&G FINISHED CEDAR DECKING.
13. GLUE LAMINATED STRUCTURE ABOVE.
14. EDGE OF ROOF ABOVE.
15. PRECAST TRIM COLUMN CAP - SEE DETAIL 7/A1.1.
16. PL 3/8" x 8" x 1'-0", TYP OF 2.
17. PRECAST TRIM WATERTABLE.
18. COLUMN ENCLOSURE BELOW.
19. (6) 3/8" Ø GALVANIZED A325 BOLTS @ 4' X 4' O.C.
20. PRECAST STONE BASE COURSE UNIT. BASIS OF DESIGN: CUSTOM CAST STONE 4' X 8' X 24" - COLOR GLACIER MIST. CHAMFER TOP EDGE.
21. CAP PLATE. SEE STRUCTURAL DRAWINGS.
22. PAIR OF 1 3/4" CONDUITS. STUB OUT 4" ABOVE PRECAST TRIM COLUMN CAP. SEE PLAN FOR COLUMN LOCATIONS. CONTRACTOR TO VERIFY SIZE WITH OWNER PRIOR TO INSTALLATION.
23. PREFINISHED METAL DRIP EDGE.
24. HSS 9x9x3/8" COLUMN.
25. PROVIDE MASONRY TIES @ 2'-0" ELEVATION INCREMENTS.
26. BASE PLATE. SEE STRUCTURAL DRAWINGS.
27. CAST STONE VENEER. BASIS OF DESIGN: ARRISCRAFT INTERNATIONAL CITADEL (4 UNIT) - TRADITIONAL GREY
28. TRIM KEYSTONE - SEE DETAIL 7/A1.2-COLOR GLASIER MIST-CUSTOM CAST STONE.
29. STEEL PLATES & BOLTS. SEE STRUCTURAL DRAWINGS.
30. STEP MASONRY AT 1/2" INCREMENTS.
31. FLASHING AROUND BASE OF COLUMN.
32. NON-SHRINK GROUT UNDER PLATE. SEE STRUCTURAL DRAWINGS.

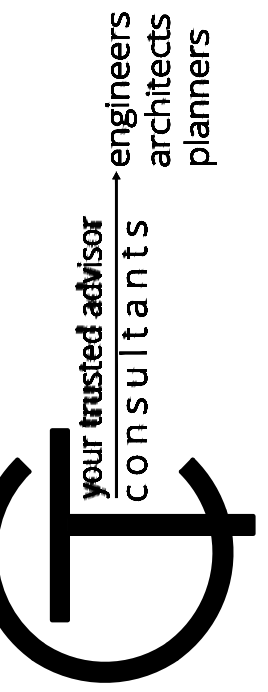

NO	REVISION	DATE
1	95% OWNER REVIEW	07/30/19
2	ISSUED FOR PERMIT	08/07/19
3	ISSUED FOR REBID	09/26/19

TOWER PARK SHELTER #3
CITY OF FORT THOMAS
- CAMPBELL COUNTY, KENTUCKY -

PROJECT NO.	190571
DISCIPLINE	ARCH
SHEET NUMBER	A1.1