
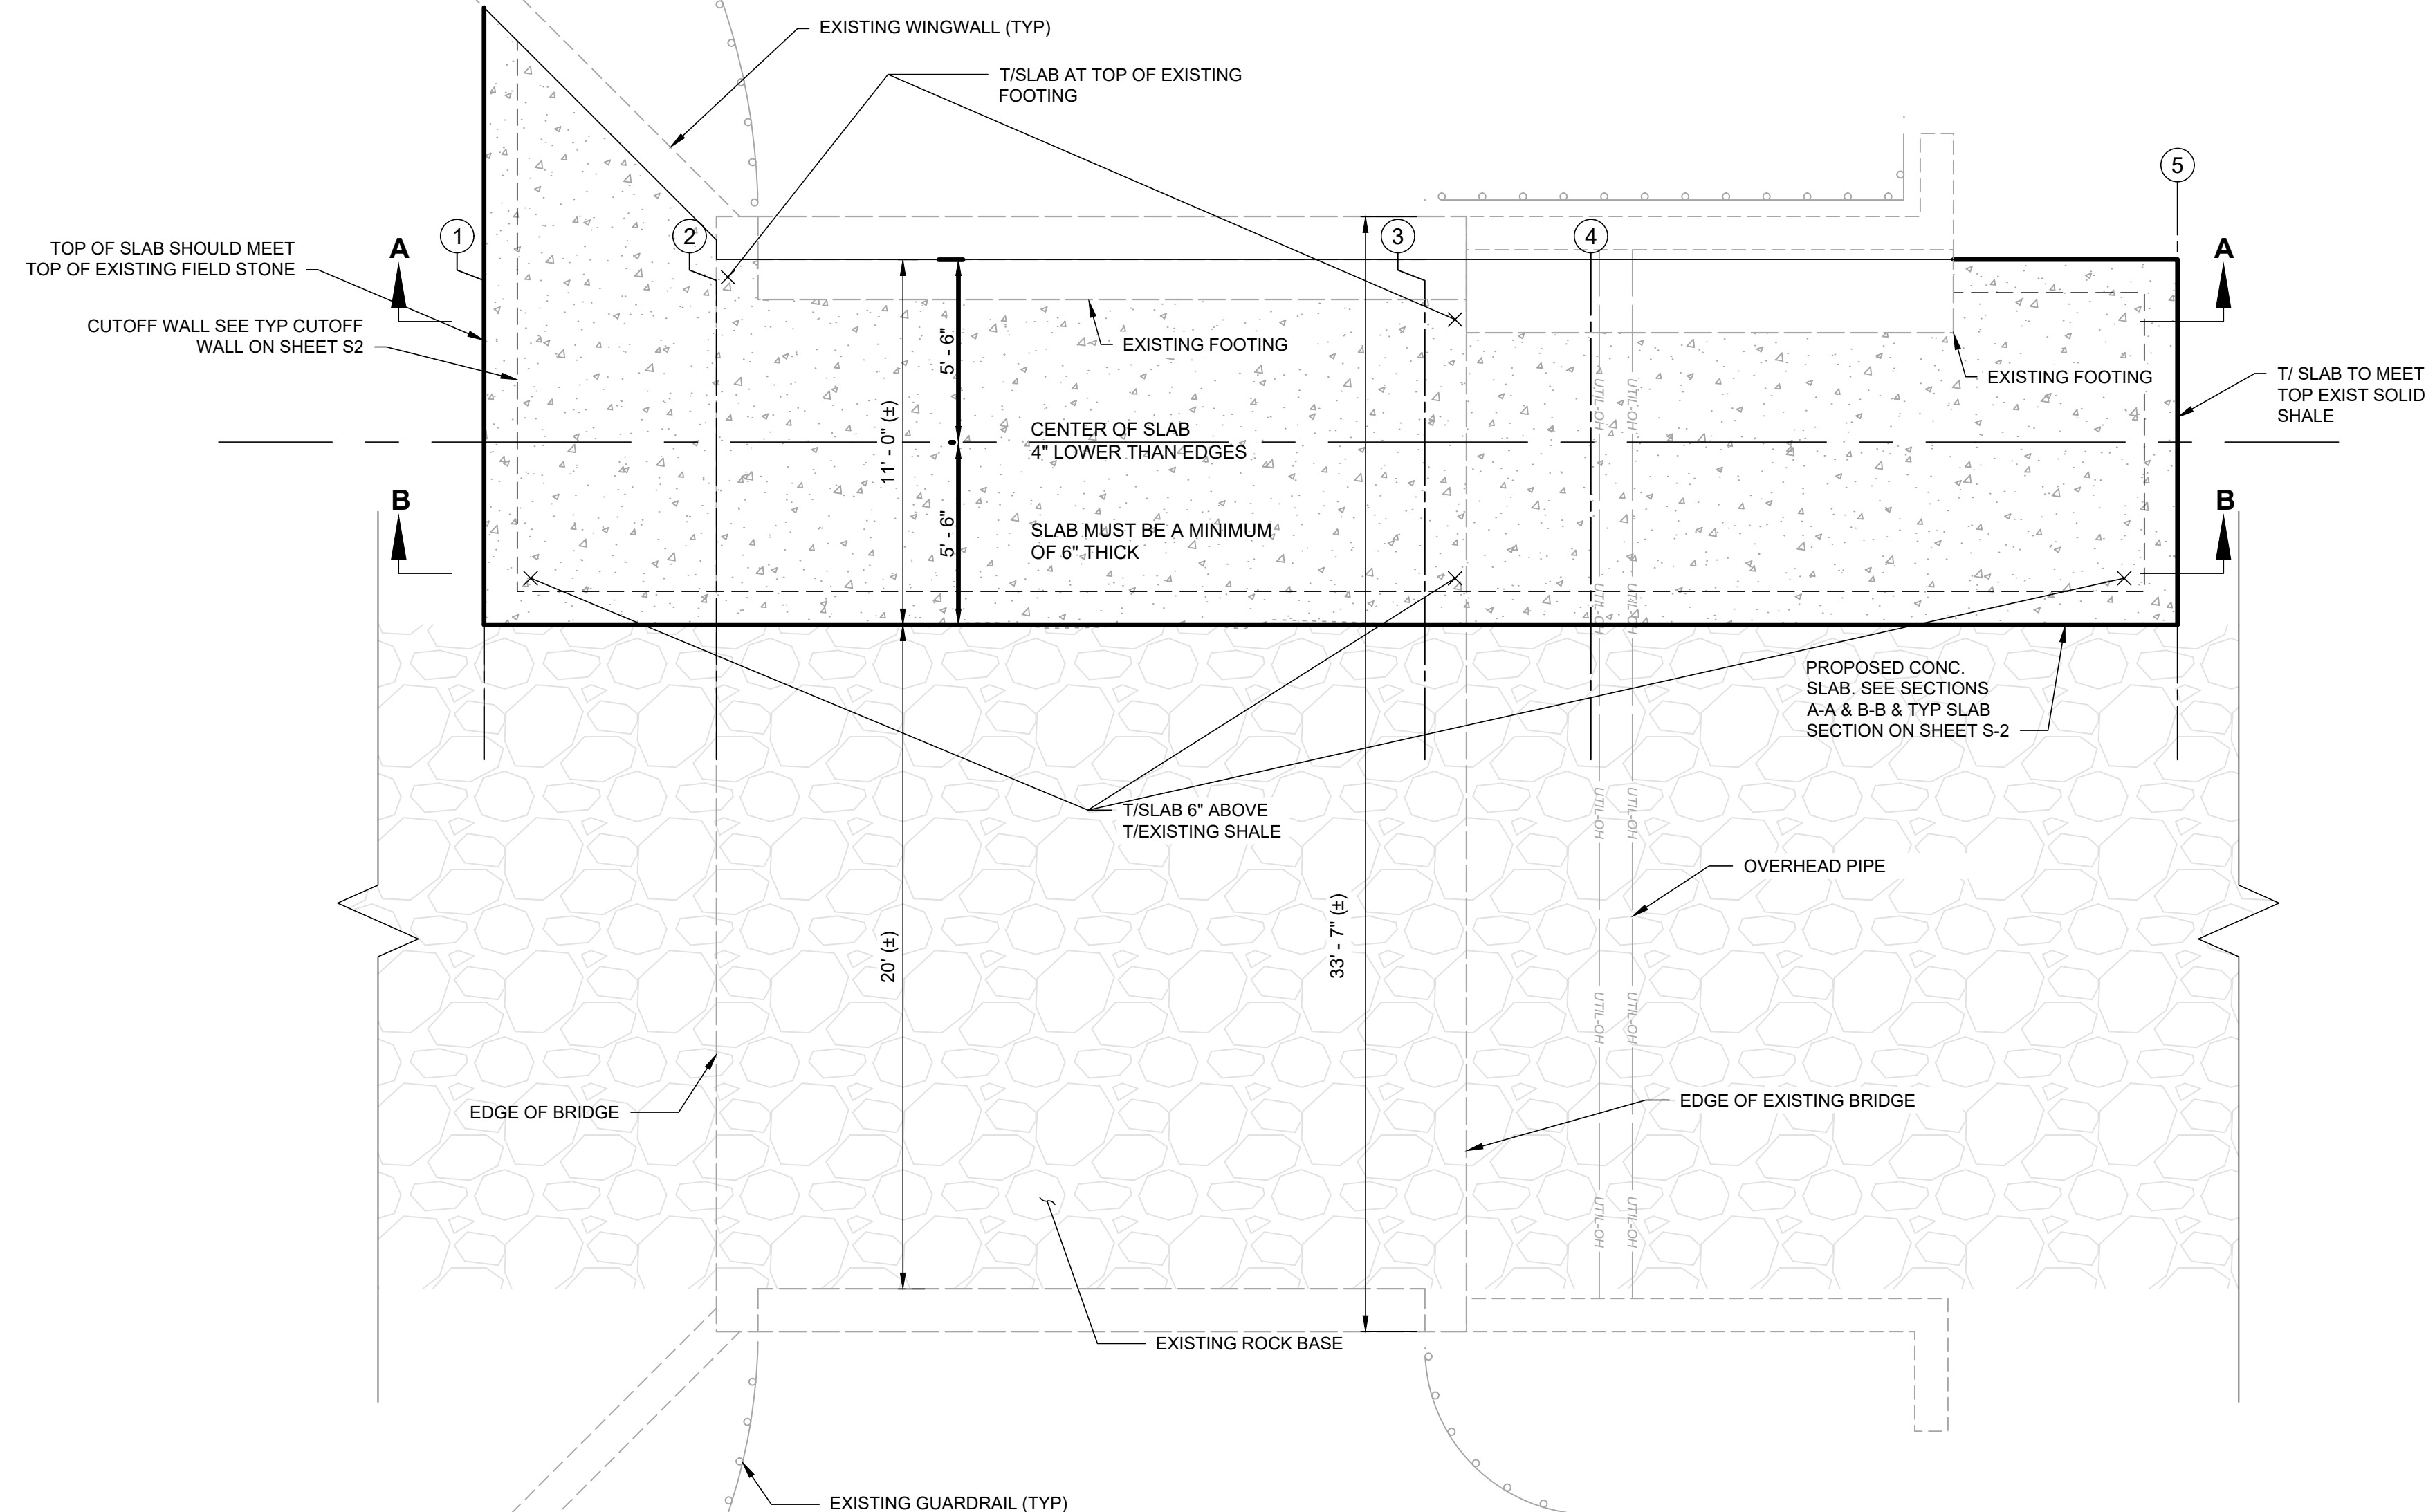


PRELIMINARY

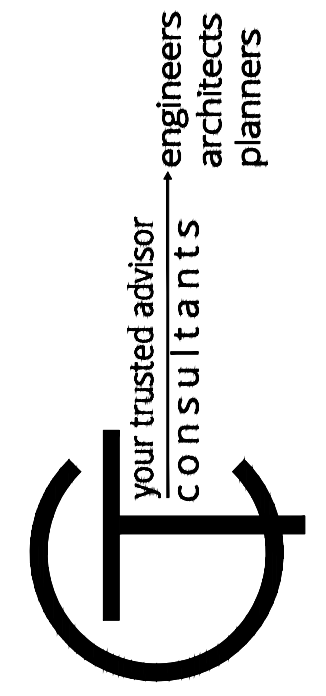

REMOVE ALL LOOSE ROCK, GABIONS, ETC FROM AREA WHERE SLAB WILL BE PLACED.


ALL ROCK REMOVED SHOULD BE PLACED ALONG THE NORTH AND EAST EDGES OF THE SLAB AND ON THE NORTH SIDE OF THE CREEK.

ONLY GABION BASKETS SHOULD BE REMOVED FROM SITE.

THE CONTRACTOR MUST PUMP THE CREEK WATER AROUND THE CONCRETE SLAB WHILE THE SLAB IS BEING PLACED.

CONTINUE PUMPING WATER AROUND THE SLAB UNTIL IT REACHES 70% OF ITS STRENGTH. NOTE, WE HAVE SPECIFIED A 7 DAY STRENGTH OF 4000 PSI.

BRIDGE EROSION CONTROL PLAN
SCALE: 1/4" = 1' - 0"

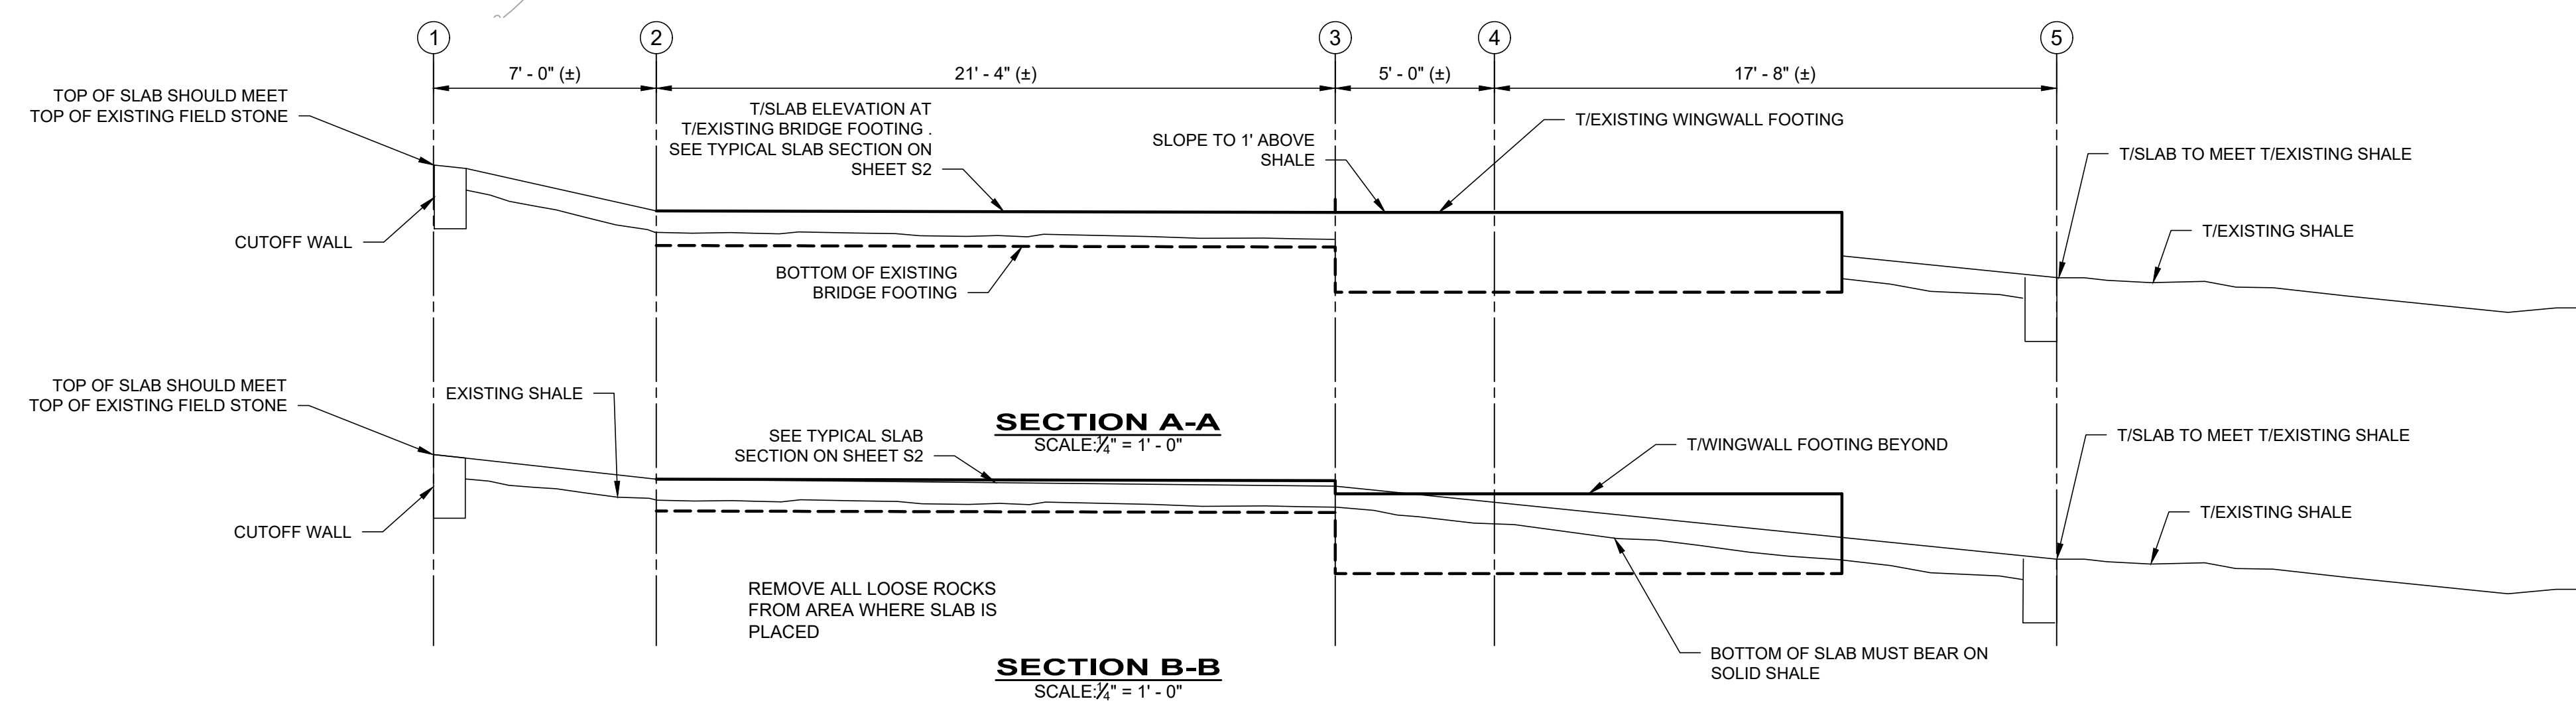

ISSUED FOR:	XX% REVIEW	NO	REVISION	DATE
ISSUE DATE:	2/21/2020			
SCALE:	1/4" = 1' - 0"			
DESIGNED BY:	RDRE			
DRAWN BY:	JLAM			
CHECKED BY:	RDRE			

**RUST ROAD BRIDGE
EROSION REMEDIATION**
- CITY OF TAYLOR MILL -

PLAN AND PROFILE

PROJECT NO.	200078
DISCIPLINE	STRUCTURAL
SHEET NAME	S1
SHEET	OF
1	2